


Contract Drawings For

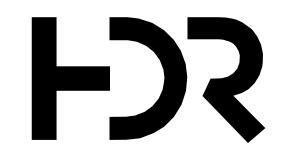

CEDAR RAPIDS KJELDAHL HOOD PROCUREMENT

Project No. 6150024-02 Project No. 10058757 7525 Bertram Rd SE, Cedar Rapids, IA 52403

04/26/2018 **ISSUED FOR BID**

	Sheet List Copy 1			
Sheet Number	Sheet Name			
00 - GENERAL	(G)			
02G001	GENERAL LEGEND			
02G002	MECHANICAL LEGEND			
02G003	ELECTRICAL LEGEND 1			
02G004	ELECTRICAL LEGEND 2			
01 - DEMOLITI	ON (X)			
02X101	KJELDAHL HOOD DEMOLITION			
07 - UNIVERSA	L (U)			
02U101	MECHANICAL AND ELECTRICAL PLANS			
09 - ARCHITEC	TURAL (A)			
02A101	KJELDAHL HOOD REPLACEMENT			




I hereby certify that this engineering document was prepared by me or under my direct personal supervision and that I am a duly licensed Professional Engineer under the laws of the State of lowa.

Michael Butterfield

My license renewal date is December 31, 2018

Pages or sheets covered by this seal:

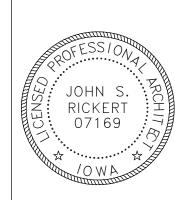


CERTIFICATION

I hereby certify that this engineering document was prepared by me or under my direct personal supervision and that I am a duly licensed Professional Engineer under the laws of the State of Iowa.

John S. Rickert

My Icense renewal date is December 31, 2018

Pages or sheets covered by this seal: 02X101, 02A101

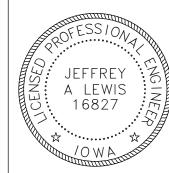

CERTIFICATION

hereby certify that this engineering document was prepared by me or under my direct personal supervision and that I am a duly licensed

Pages or sheets covered by this seal: 02G002, 02U101




CERTIFICATION

I hereby certify that this engineering document was prepared by me or under my direct personal supervision and that I am a duly licensed Professional Engineer under the laws of the State of lowa. 4-26-18

My license renewal date is December 31, 2018

Pages or sheets covered by this seal: 02G003,02G004,02U101

ISSUED FOR BID

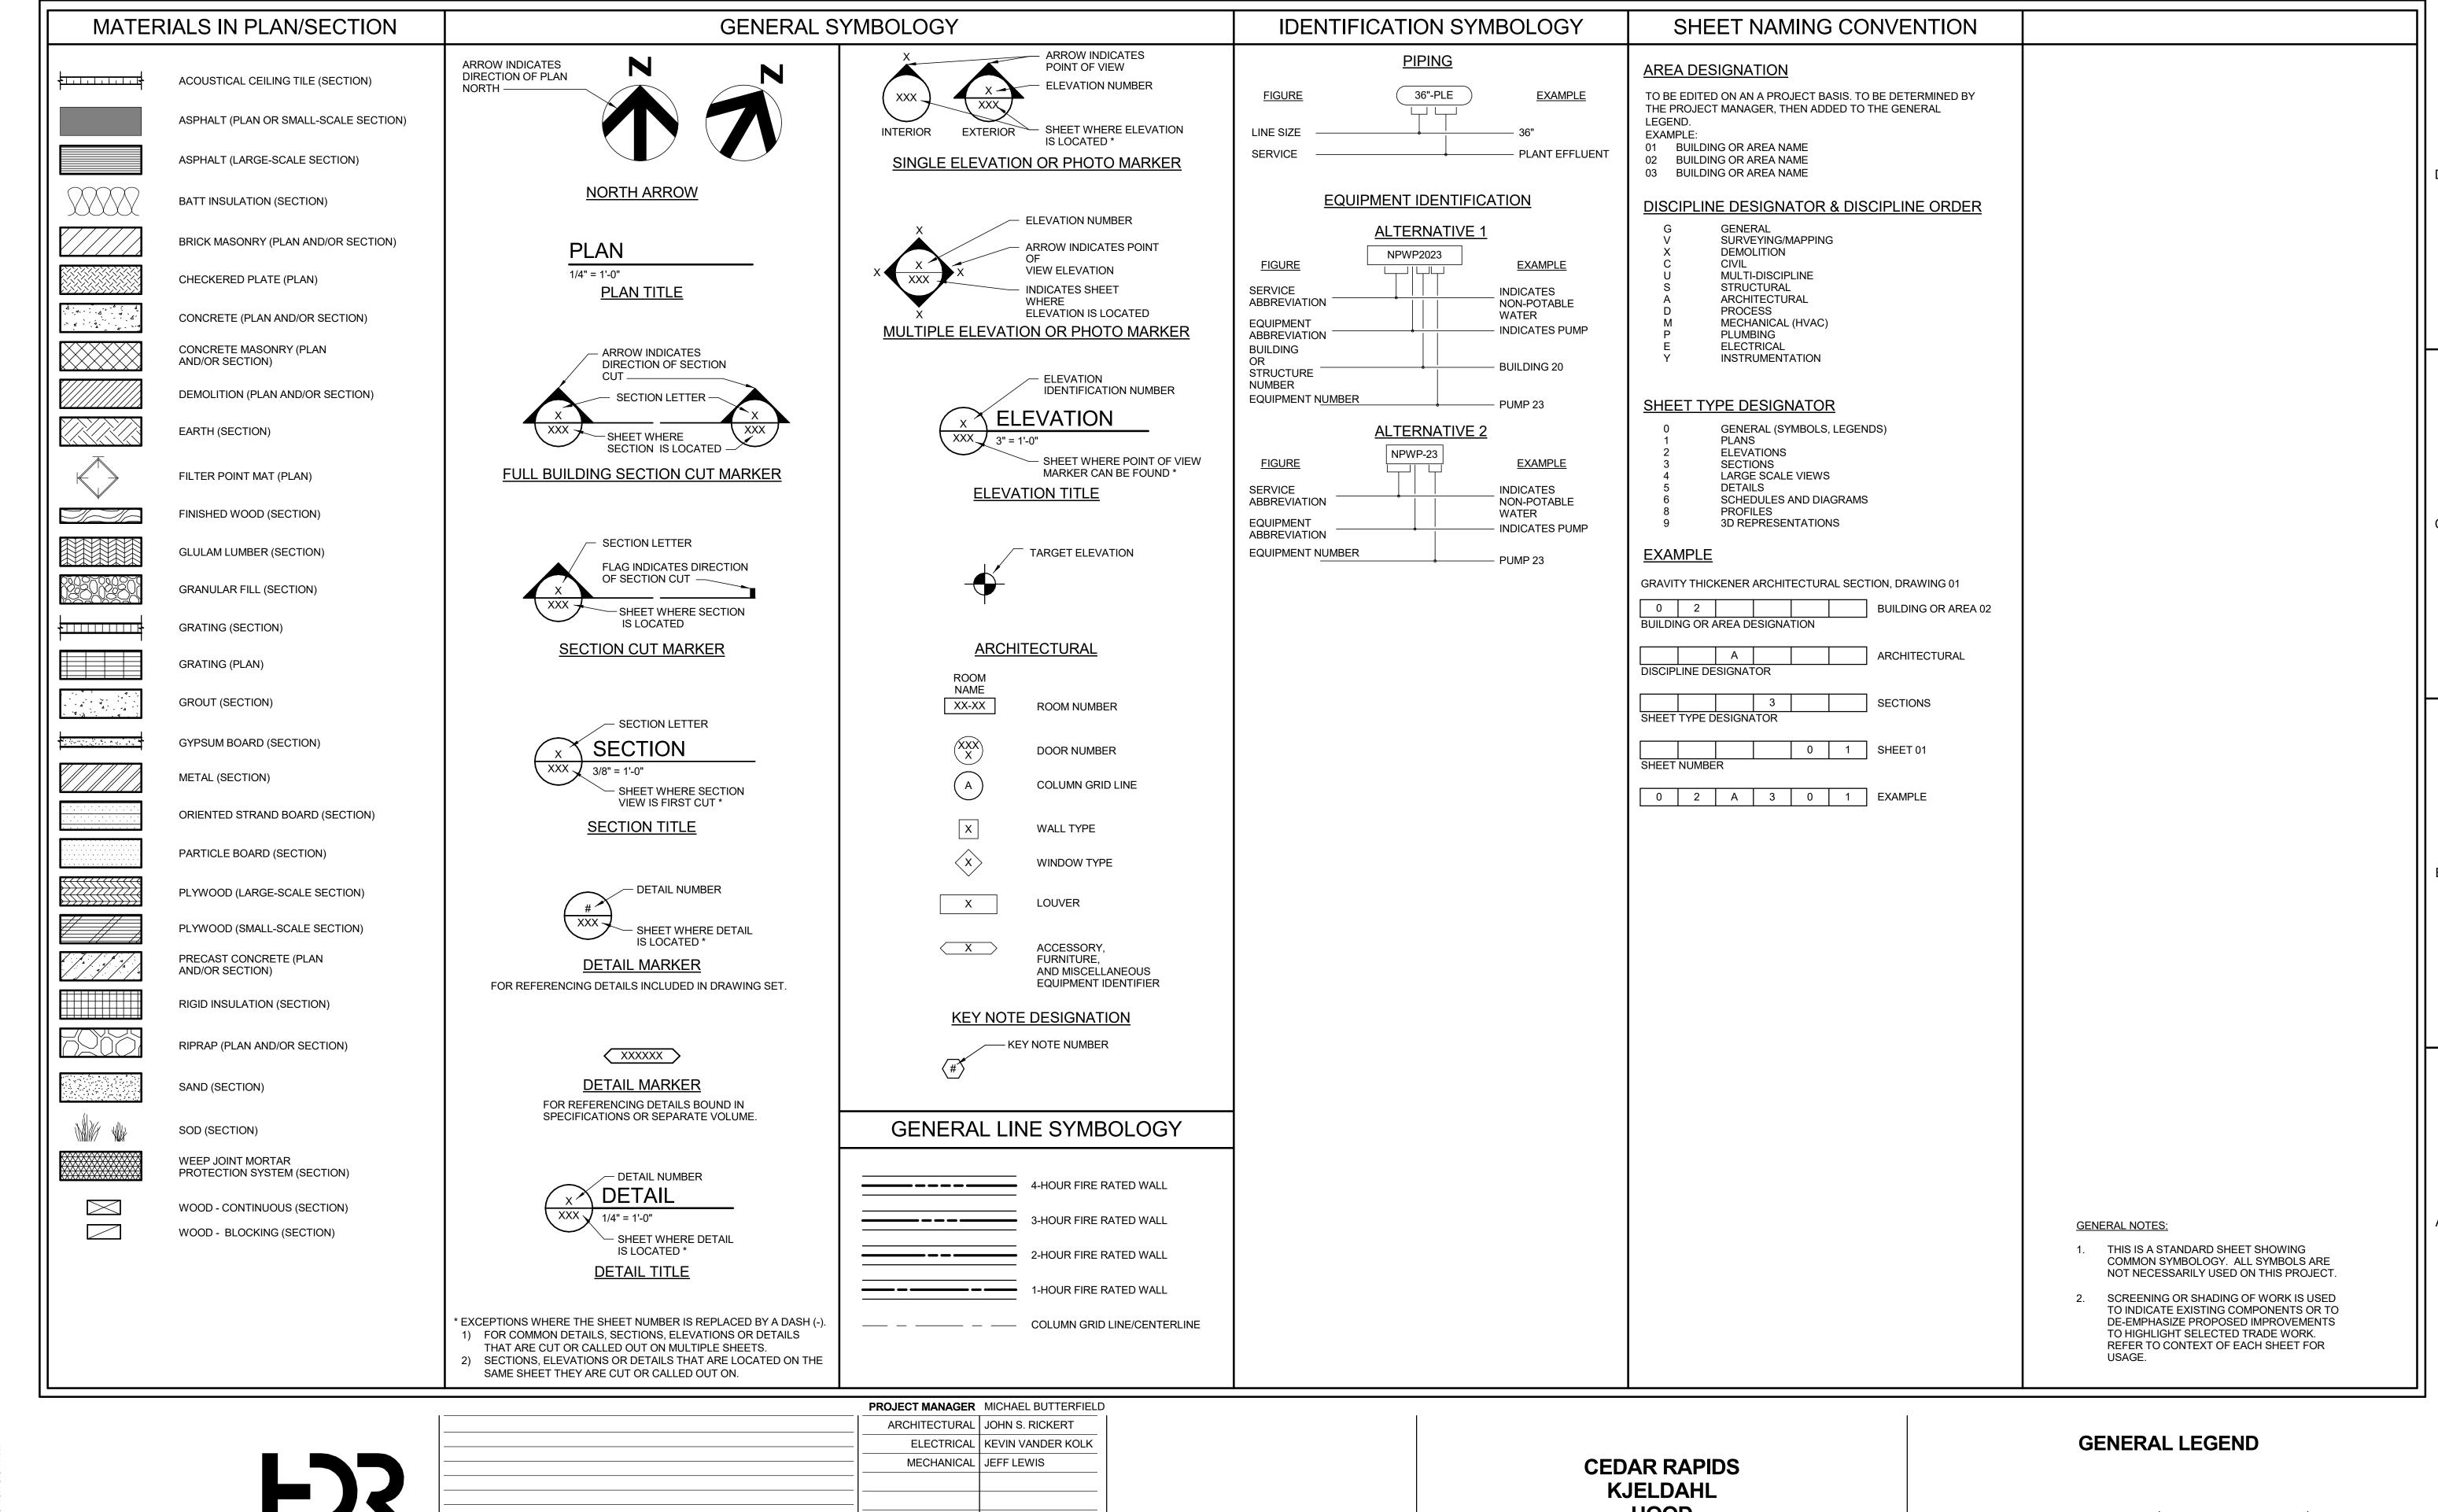


04/26/2018 ISSUED FOR BID DATE DESCRIPTION PROJECT NUMBER | 10058757

HOOD **PROCUREMENT**




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FJS

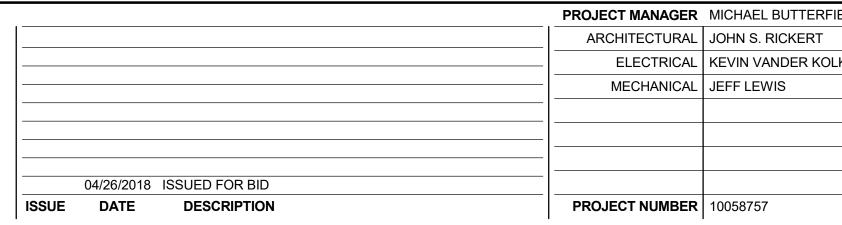

CEDAR RAPIDS KJELDAHL HOOD **PROCUREMENT**

FILENAME | HDRE_ALL_DISCIPLINES.rte | SHEET 02G002

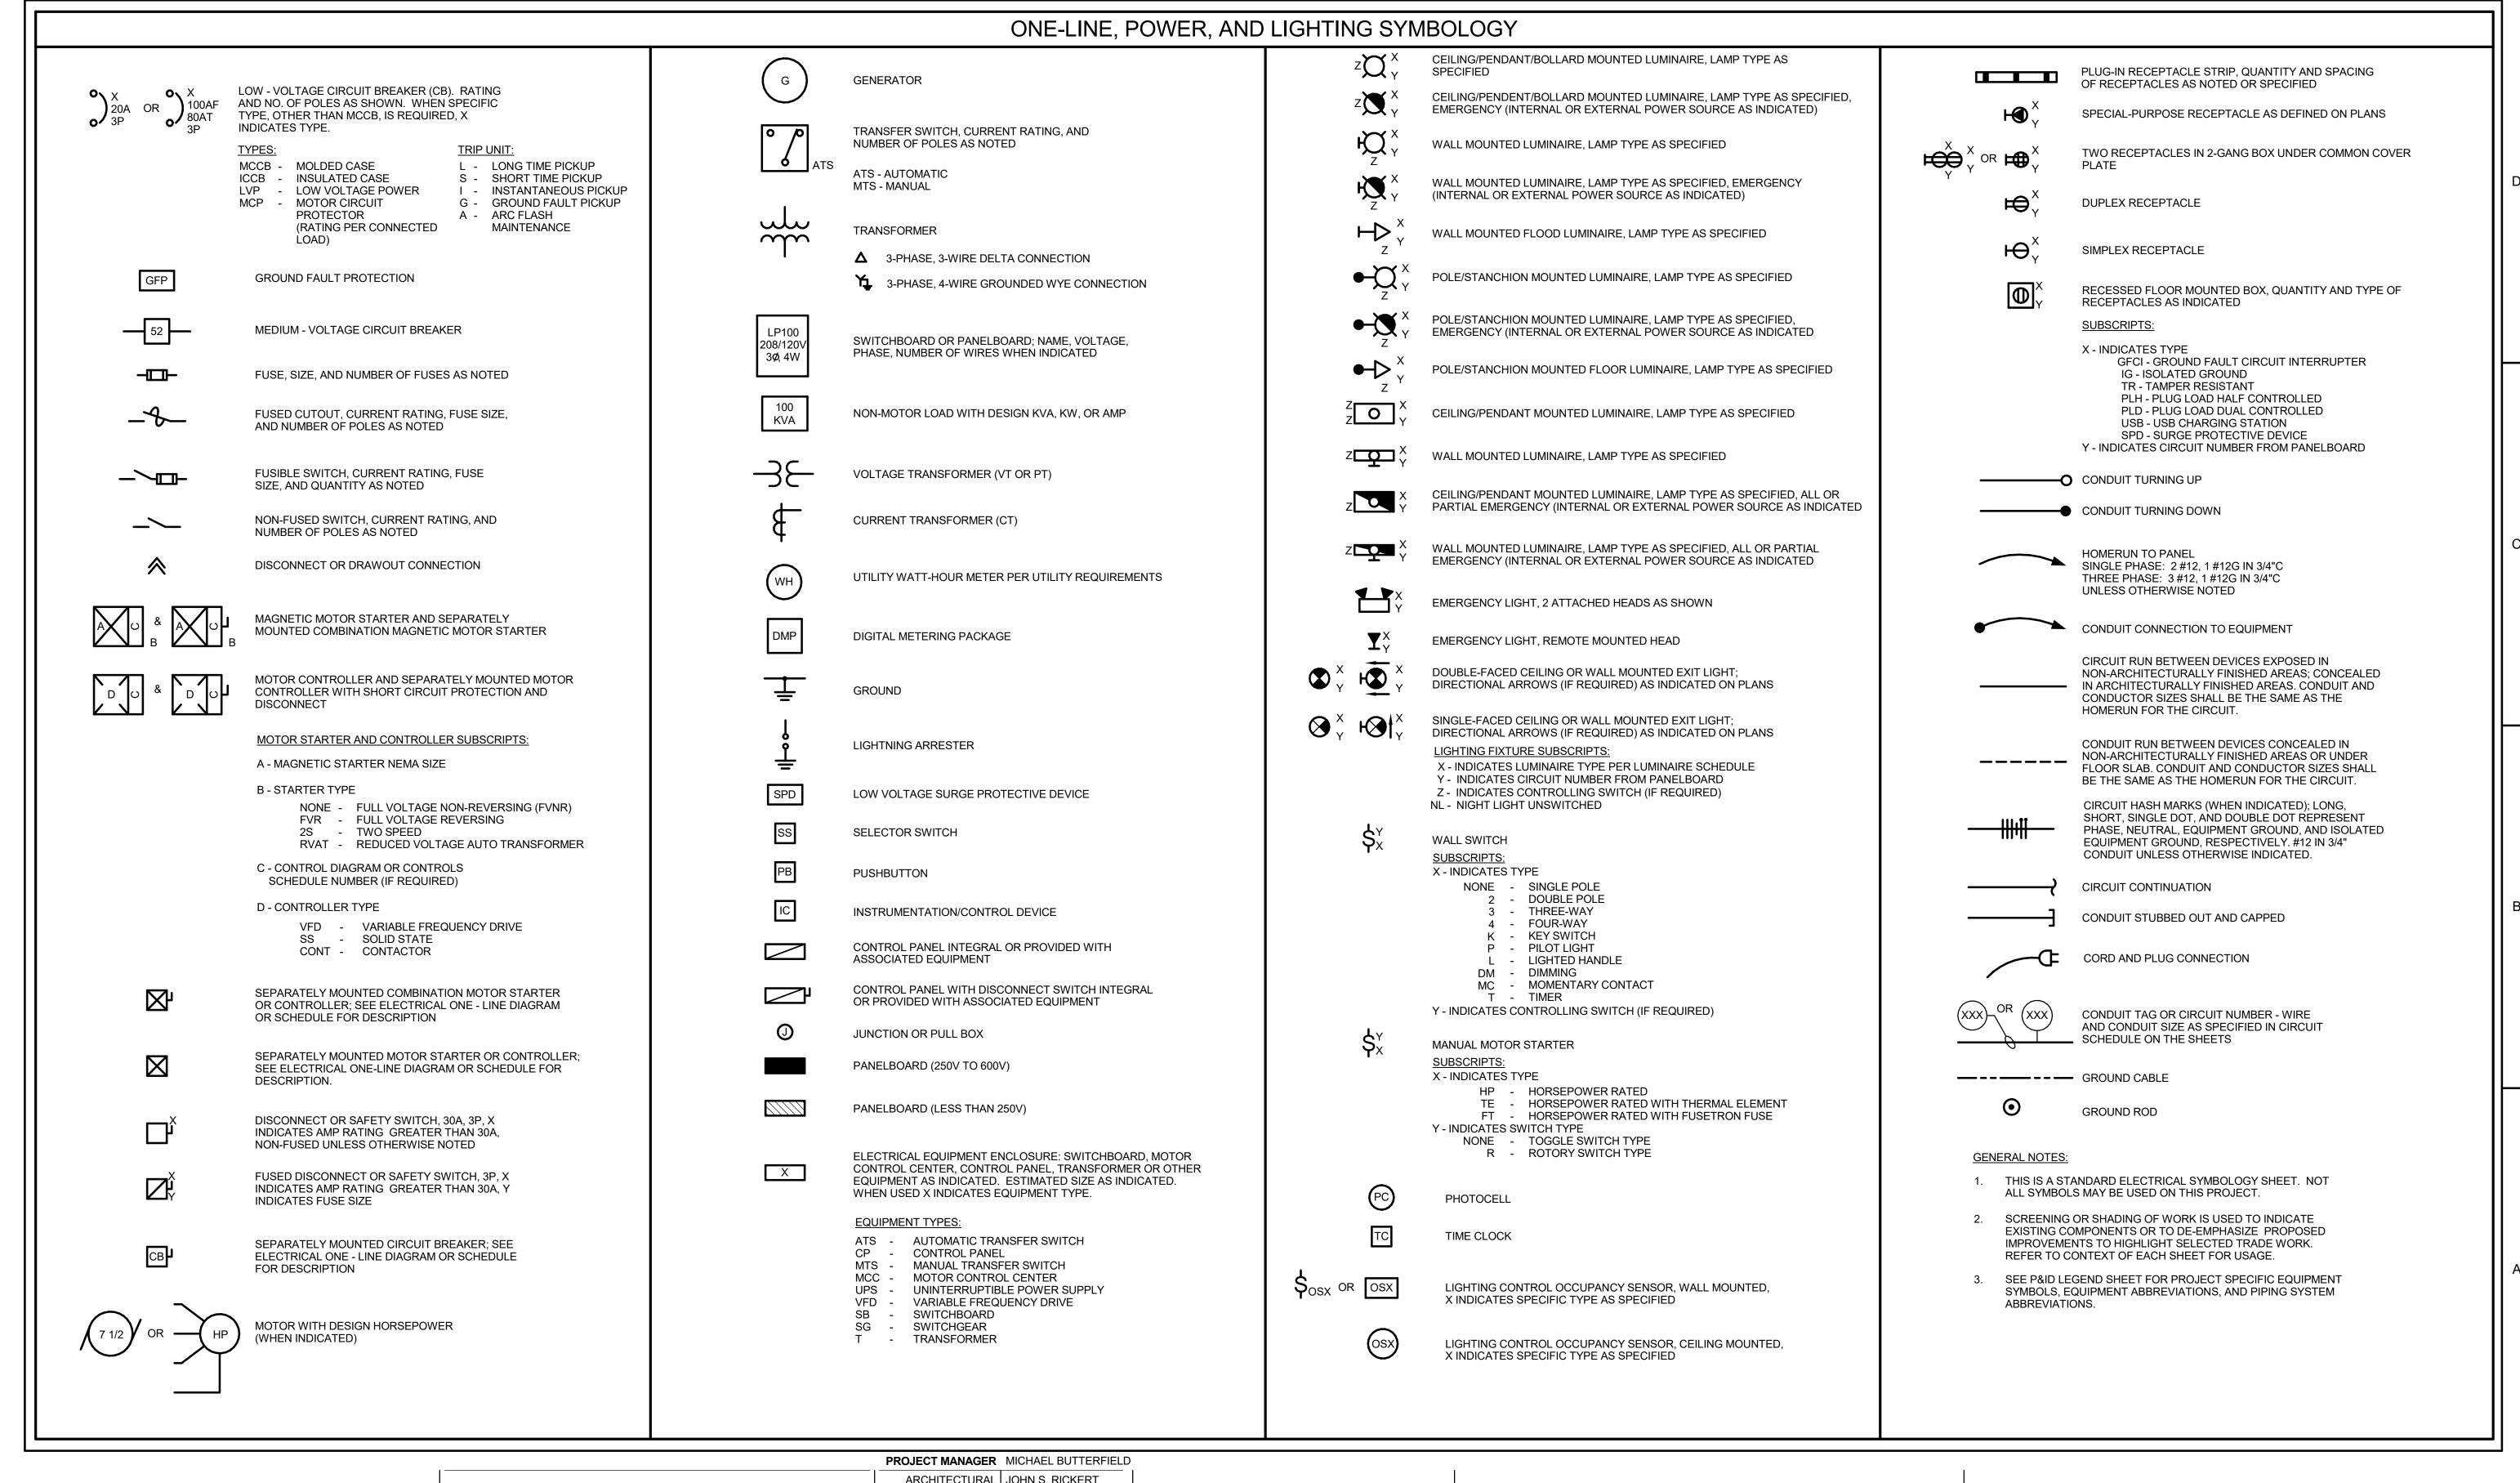

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ARCHITECTURAL JOHN S. RICKERT

ELECTRICAL KEVIN VANDER KOLK

MECHANICAL JEFF LEWIS

04/26/2018 ISSUED FOR BID

ISSUE DATE DESCRIPTION

PROJECT NUMBER 10058757

CEDAR RAPIDS

KJELDAHL

HOOD

PROCUREMENT

ELECTRICAL LEGEND 1



FILENAME HDRE_ALL_DISCIPLINES.rte SHEET


02G003

		PROJECT MANAGER	MICHAEL B
		ARCHITECTURAL	JOHN S. RI
		ELECTRICAL	KEVIN VAN
		MECHANICAL	JEFF LEWIS
- / -			
•	04/26/2018 ISSUED FOR BID		
	ISSUE DATE DESCRIPTION	PROJECT NUMBER	10058757

CEDAR RAPIDS
KJELDAHL
HOOD
PROCUREMENT

0 1" 2" FILENAME HDRE_ALL_DISCIPLINES.rte SHEET SCALE NONE SCALE

Management Man	COMMUNICATION SYMBOLOGY	MASS NOTIFICATION SYMBOLOGY	CONTROL SYMBOLOGY	CONTROL SYMBOLOGY
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Management Ma	WALL MOUNTED COMBINATION TELEPHONE AND DATA OUTLET		'	LENS COLORS:
AUDIONISUAL SYMBOLOGY AUDIONISUAL SYMBOLOGY CLASSIAN TOTAL CONTROL TO THE CONTR			X-INDICATES TYPE Y-INDICATES LOOP NUMBER, WHEN USED TYPES: CR-CONTROL RELAY TC-TIME CLOCK	G - GREEN W - WHITE
AUDIOVISUAL SYMBOLOGY Control of the control of		—7	DP-DEFINITE PURPOSE TR-TIMING RELAY	OL
AL MONTHLY STATE AND STATE	AUDIO/VISUAL SYMBOLOGY	_		THERMAL OVERLOAD RELAY CONTACT. WHEN SHOWN X INDICATES QUANTITY.
O MARIA SERVICIO IN PLANTAGE IN TOUR AND TO TO MARIA SERVICIONAL MICHAEL SERVICIONAL SERV				CPT CONTROL POWER TRANSFORMER (CPT)
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Security descriptions Property	SPEAKER SUBSCRIPTS:	MF COMBINATION MASS NOTIFICATION/FIRE ALARM STROBE	NORMALLY OPEN TIME DELAY RELAY CONTACT WITH TIME DELAY ON OPENING AFTER COIL IS DE-ENERGIZED	FIRE ALARM SYMBOLOGY
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R PROXIMITY CARSI READER WITH KEYPARD LOTTEROR PARD MOUNTED TRANSFORMER DIAM THORNOO DRY MOTION DETECTOR REQUEST TO EAST MOTION D				D - FIRE OR SMOKE DAMPER
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G G GLASS BREAK DETECTOR HIGH MAST LIGHTING, NUMBER OF LUMINAIRES AS SPECIFIED LIGHTING FIXTURE SUBSCRIPTS: X - INDICATES LUMINAIRE TYPE PER LUMINAIRE SCHEDULE PTZ CCTV CAMERA PANTILITZOOM WHEN INDICATED FIX REMOTE KEYPAD/CONTROL STATION FIX NORMALLY OPEN PUSHBUTTON, MOMENTARY CONTACT NORMALLY CLOSED PUSHBUTTON, MOMENTARY CONTACT FIX HORN/SPEAKER AND FLASHING LIGHT COMBINATION UNIT NORMALLY CLOSED PUSHBUTTON, MOMENTARY CONTACT NORMALLY CLOSED PUSHBUTTON, MOMENTARY CONTACT FIX HORN/SPEAKER AND FLASHING LIGHT COMBINATION UNIT NORMALLY CLOSED PUSHBUTTON, MOMENTARY CONTACT FIX HORN/SPEAKER AND FLASHING LIGHT COMBINATION UNIT NORMALLY CLOSED PUSHBUTTON, MOMENTARY CONTACT NORMALLY CLOSED PUSHBUTTON, MOMENTARY CONTACT FIX BELLSPEAKER AND FLASHING LIGHT COMBINATION UNIT		POLE/STANCHION MOUNTED FLOOD LUMINAIRE, LAMP TYPE AS SPECIFIED		IR - INFRARED UV - ULTRAVIOLET
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REMOTE KEYPAD/CONTROL STATION OVERHEAD ELECTRICAL AND COMMUNICATION SYSTEMS PATHWAY OVERHEAD ELECTRICAL AND COMMUNICATION SYSTEMS PATHWAY NORMALLY OPEN PUSHBUTTON, MOMENTARY CONTACT UNLESS OTHERWISE NOTED NORMALLY OPEN PUSHBUTTON, MOMENTARY CONTACT UNLESS ON OTHERWISE NOTED BELL/SPEAKER AND FLASHING LIGHT COMBINATION UNIT	SEC SECURITY EQUIPMENT CABINET	DOWNGUY	OTHERWISE NOTED, 2-POSITION SIMILAR	
	REMOTE KEYPAD/CONTROL STATION	PATHWAY	O O OTHERWISE NOTED NORMALLY CLOSED PUSHBUTTON, MOMENTARY CONTACT	

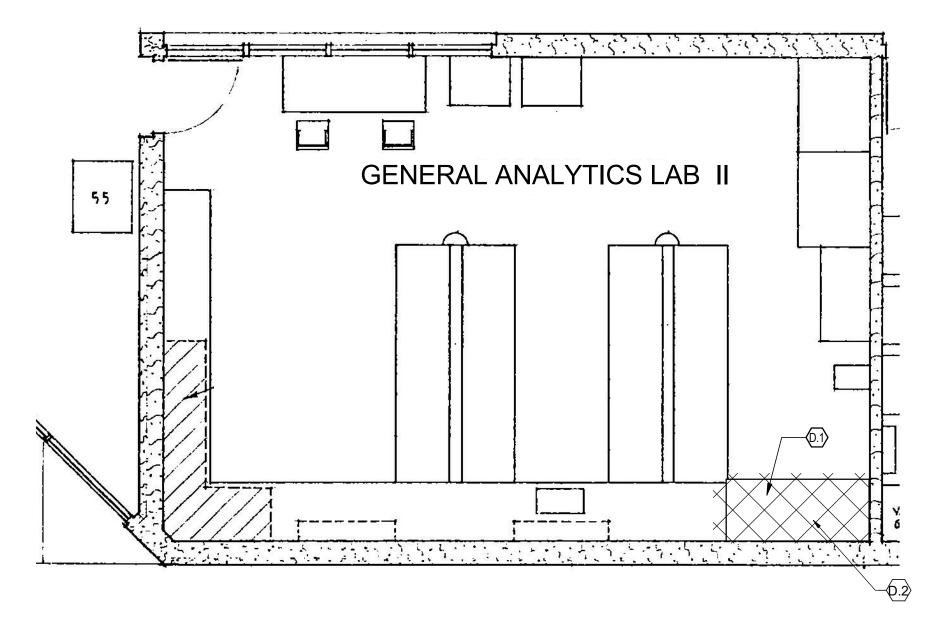

DEMOLITION FLOOR PLAN - KJELDAHL

1/4" = 1'-0"

DEMOLITION KEYNOTES

- D.1 REMOVE KJELDAHL HOOD, ITEM IS NOT TO BE SALVAGED.
- DISCONNECT ELECTRICAL CONDUIT AND WIRE. PREPARE FOR RECONNECTION TO NEW HOOD.

DEMOLITION NOTES:

- REFER TO THE MECHANICAL AND ELECTRICAL PLANS FOR EXTENT OF ASSOCIATED WORK INCLUDING BUT NOT LIMITED TO WIRING, CONDUIT, JUNCTION BOXES, PIPING, DRAINAGE AND EQUIPMENT, DUCT WORK AND FANS.
- MAINTAIN CLEAR ACCESS TO EXITS THROUGHOUT DEMOLITION AND CONSTRUCTION.
- CONTRACTOR, AT ALL TIMES, SHALL MAINTAIN THE WEATHERTIGHTNESS OF THE BUILDING.
- CONTRACTOR SHALL FIELD VERIFY ALL EXISTING CONSTRUCTION RELATED CONDITIONS AND DIMENSIONS PRIOR TO STARTING DEMOLITION AND CONSTRUCTION.
- EXISTING ITEMS, EQUIPMENT, FIXTURES, ETC. TO REMAIN SHALL BE PROTECTED FROM DIRT AND DAMAGE DURING DEMOLITION AND CONSTRUCTION.
- RECONNECT NEW KJELDAHL HOOD TO EXISTING CONNECTIONS.

PROJECT MANAGER MICHAEL BUTTERFIELD ARCHITECTURAL JOHN S. RICKERT ELECTRICAL | KEVIN VANDER KOLK F)S MECHANICAL | JEFF LEWIS 04/26/2018 ISSUED FOR BID DATE DESCRIPTION PROJECT NUMBER | 10058757

CEDAR RAPIDS KJELDAHL HOOD **PROCUREMENT** **KJELDAHL HOOD DEMOLITION**

FILENAME | HDRE_ALL_DISCIPLINES.rte | SHEET


02X101

MOTOR DIAGRAM FOR EF-06B IS SIMILAR EXCEPT ON/OFF SWITCH IS REPLACED BY CR1 CONTACT.

L----



MOTOR STARTER

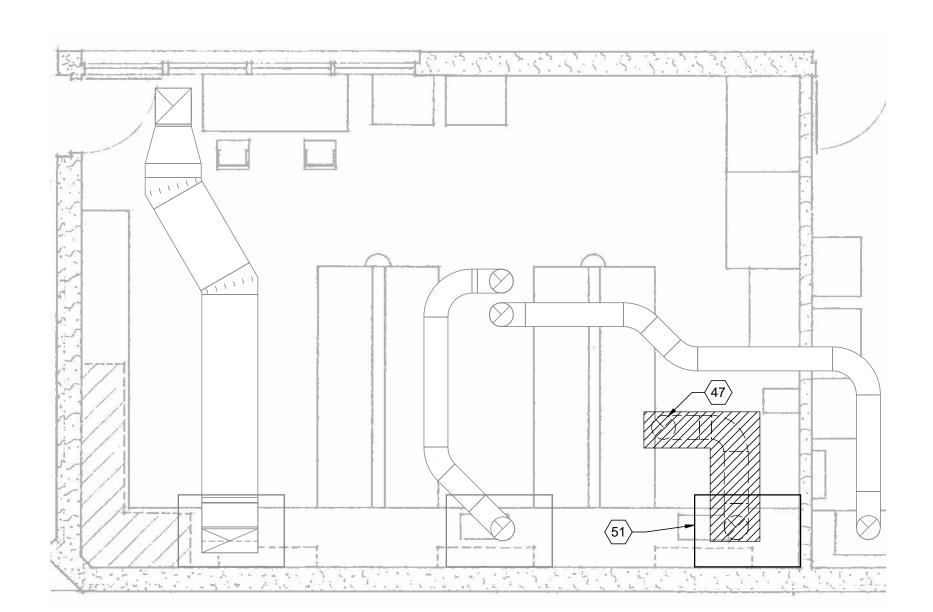

GENERAL ANALYTICS LABORATORY II DEMOLITION PLAN

EXHAUST FAN SCHEDULE FAN DATA ELECTRICAL DATA EFFECTIVE SERVES PLUME HEIGHT NOTES MARK LOCATION **BASIS OF DESIGN TYPE** (FT) MK PLASTICS AXIJET-F 1225 EF-06A ROOF KJELDAHL HOOD (ACID VENT) CENTIFUGAL UPBLAST, HIGH PLUME 500 0.5 | BELT | 2,815 | 1-1/2 | 208 | 3 | 60 | 1,800 | 1, 2, 3, 4 EF-06B ROOF KJELDAHL HOOD (HOOD EXHAUST) CENTIFUGAL UPBLAST, HIGH PLUME 430 | 0.5 | BELT | 2,880 | 1-1/2 | 208 | 3 | 60 | 1,800 | MK PLASTICS AXIJET-F 1225 15

NOTES:

- 1 PROVIDE FAN AND ALL NECESSARY FAN EXTENSIONS AND ROOF CURBS TO HAVE DISCHARGE OF PLUME 10' ABOVE FINISHED ROOF SURFACE.
- 2 ALL COMPONENTS EXPOSED TO AIRSTREAM SHALL BE RESISTANT TO HCI AND H2SO4. ALL COMPONENTS NOT EXPOSED TO AIR STREAM SHALL BE RESISTANT TO H2S.
- 3 COORDINATE CONNECTION AND BALANCING OF FAN WITH KJELDAHL HOOD MANUFACTURER AND ALL REQUIRED INSTALLATION REQUIREMENTS.
- 4 FAN TO BE PROVIDED WITH A BYPASS DAMPER. AIRFLOW LISTED DOES NOT INCLUDE BYPASS AIRFLOW. MANUFACTURER SHALL PROVIDE BYPASS AIRFLOW TO MEET PLUME HEIGHT LISTED.

SEQUENCE OF OPERATIONS


LAB EXHAUST FANS A. THE LAB EXHAUST FANS SHALL BE CONTROLLED BY A LOCAL SWITCH AT THE KJELDAHL FUME HOOD.


$\underline{\mathsf{KEYNOTES}}\!\!\left\langle \mathsf{X}\right\rangle$

KJELDAHL HOOD TO BE POWERED WITH A 30A. 120/208V. 3PH. 4W CIRCUIT. REUSE EXISTING CONDUIT AND WIRE, PROVIDE WIRE REDUCTION AS REQUIRED TO FIT TERMINALS.

BREAKERS.

- REPLACE EXISTING 100A, 3P CIRCUIT BREAKER IN PANEL LA WITH 30A, 3P. PANEL LA IS A WESTINGHOUSE PANELBOARD WITH TYPE BA CIRCUIT
- NEMA 4X DISCONNECT PROVIDED WITH FAN MOUNT TO FAN ENCLOSURE. PROVIDE 3#12, 1#12G, 3/4" C TO PANEL P2 VIA MOTOR STARTER. SEE CONTROL DIAGRAM THIS SHEET.
- PROVIDE (2) 20A, 3P CIRCUIT BREAKERS FOR EF-06A AND EF-06B IN PANEL P2. PANEL IS A SQUARE D TYPE NF PANELBOARD.
- RECONNECT PWC, VAC AND AIR LINES TO FUME HOOD.
- PROVIDE 10" PVC FROM DUCT COLLAR OF THE KJELDAHL HOOD TO THE EXHAUST FAN EF-06A. TRANSITION AS REQUIRED TO CONNECT TO HOOD AND FAN. PVC DUCT SHALL BE SOLVENT WELDED AIRTIGHT AND SHALL BE ACID RESISTANT.
- DEMO EXISTING DUCTWORK AND EXISTING EXHAUST FAN ON THE ROOF.
- MOTOR STARTER FOR EF-06A.
- MOTOR STARTER FOR EF-06B.
- PROVIDE 2#14, 1#14G, 3/4 BETWEEN MOTOR STARTERS AND BETWEEN MOTOR STARTER EF-06A AND KJELDAHL HOOD CONTROL PANEL.
- KJELDAHL HOOD. SEE SHEET 02X01 AND 02A101 FOR DEMO AND NEW PLANS.

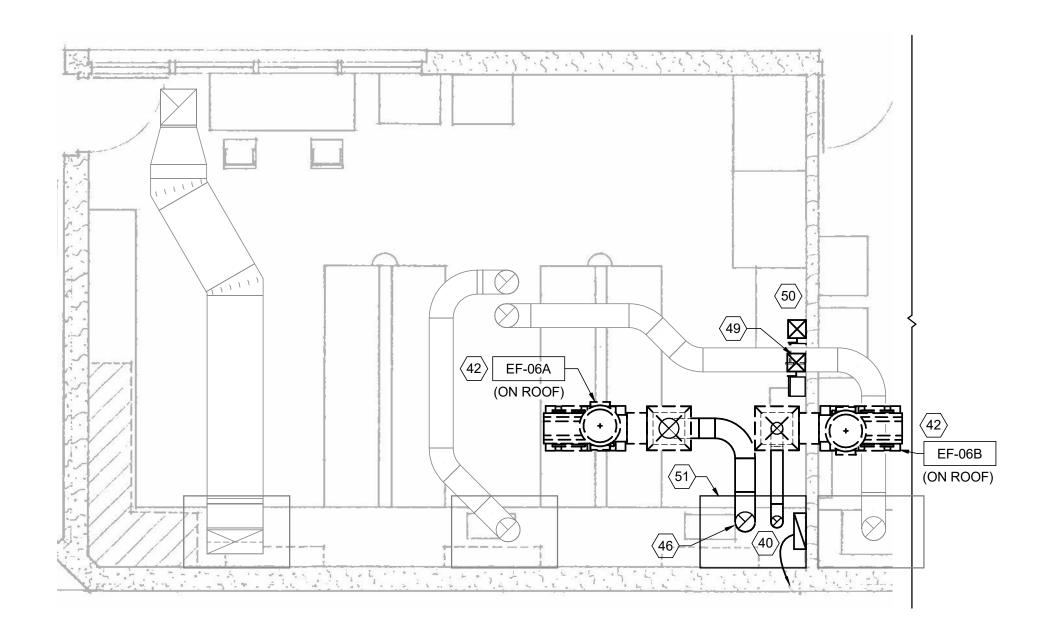

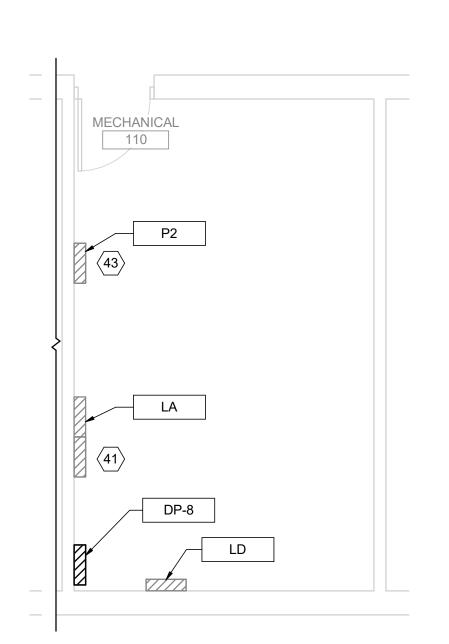

GENERAL ANALYTICS LABORATORY II PLAN

PROJECT MANAGER MICHAEL BUTTERFIELD ARCHITECTURAL ELECTRICAL | KEVIN VANDER KOLK F)S MECHANICAL JEFF LEWIS 04/26/2018 ISSUED FOR BID DATE DESCRIPTION PROJECT NUMBER | 10058757


CEDAR RAPIDS KJELDAHL HOOD **PROCUREMENT**


MECHANICAL AND ELECTRICAL PLANS



FILENAME 10058682_M_WPCF

SHEET 02U101

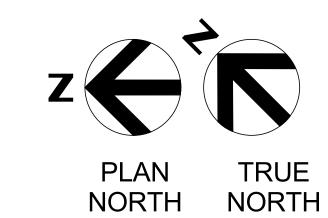

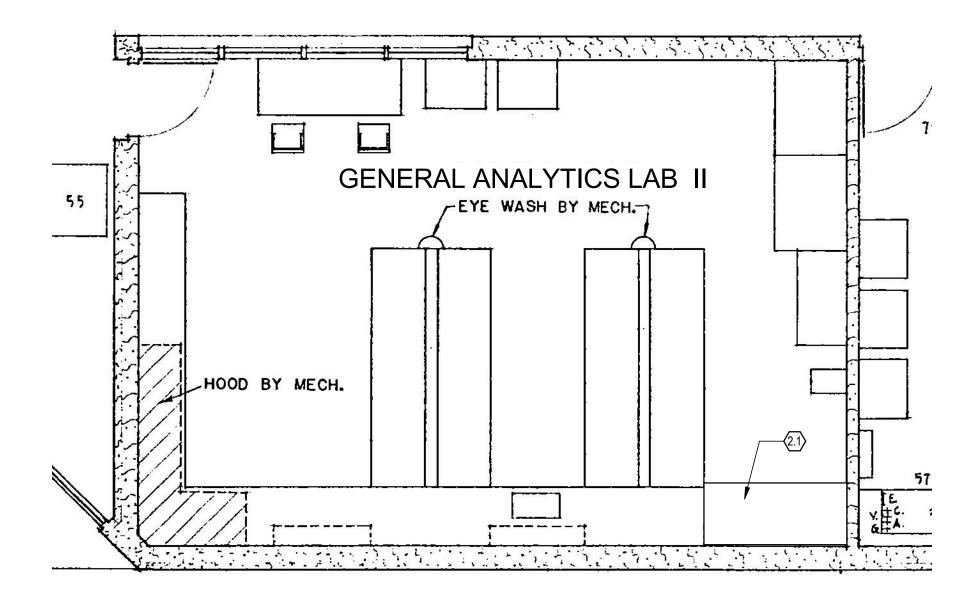



FLOOR PLAN - KJELDAHL

2.1 KJELDAHL HOOD, CONNECT VIA DUCT TO ROOF MOUNTED PLANS. RECONNECT TO EXISTING SERVICE LINES: WATER, VACUUM, AIR, ELECTRIC. RECONNECT TO EXISTING PLUMBING

KEYNOTES


2.2 NEW MECHANICAL ROOFTOP EQUIPMENT. PROVIDE ROOF CURB, PER DETAIL A/02A101. EXISTING ROOF IS EPDM. CONTRACTOR IS TO PATCH AS REQUIRED FOR A WEATHERTIGHT SYSTEM PER MANUFACTURER'S RECOMMENDATIONS.

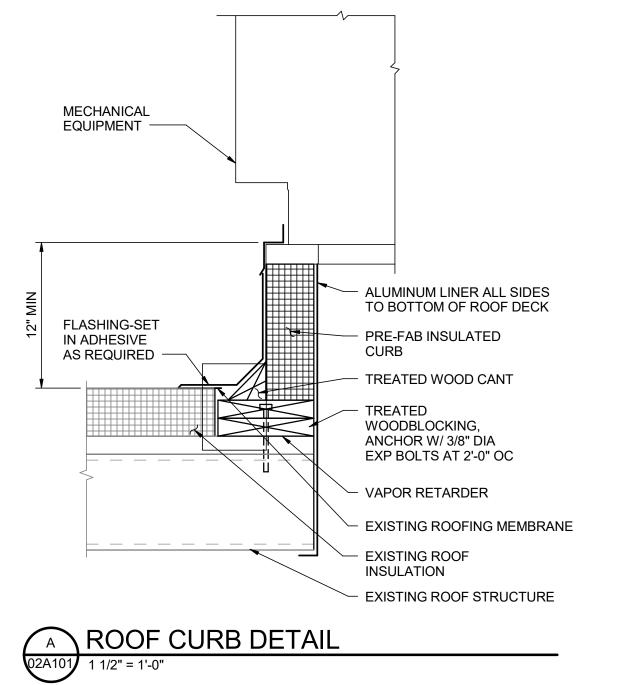

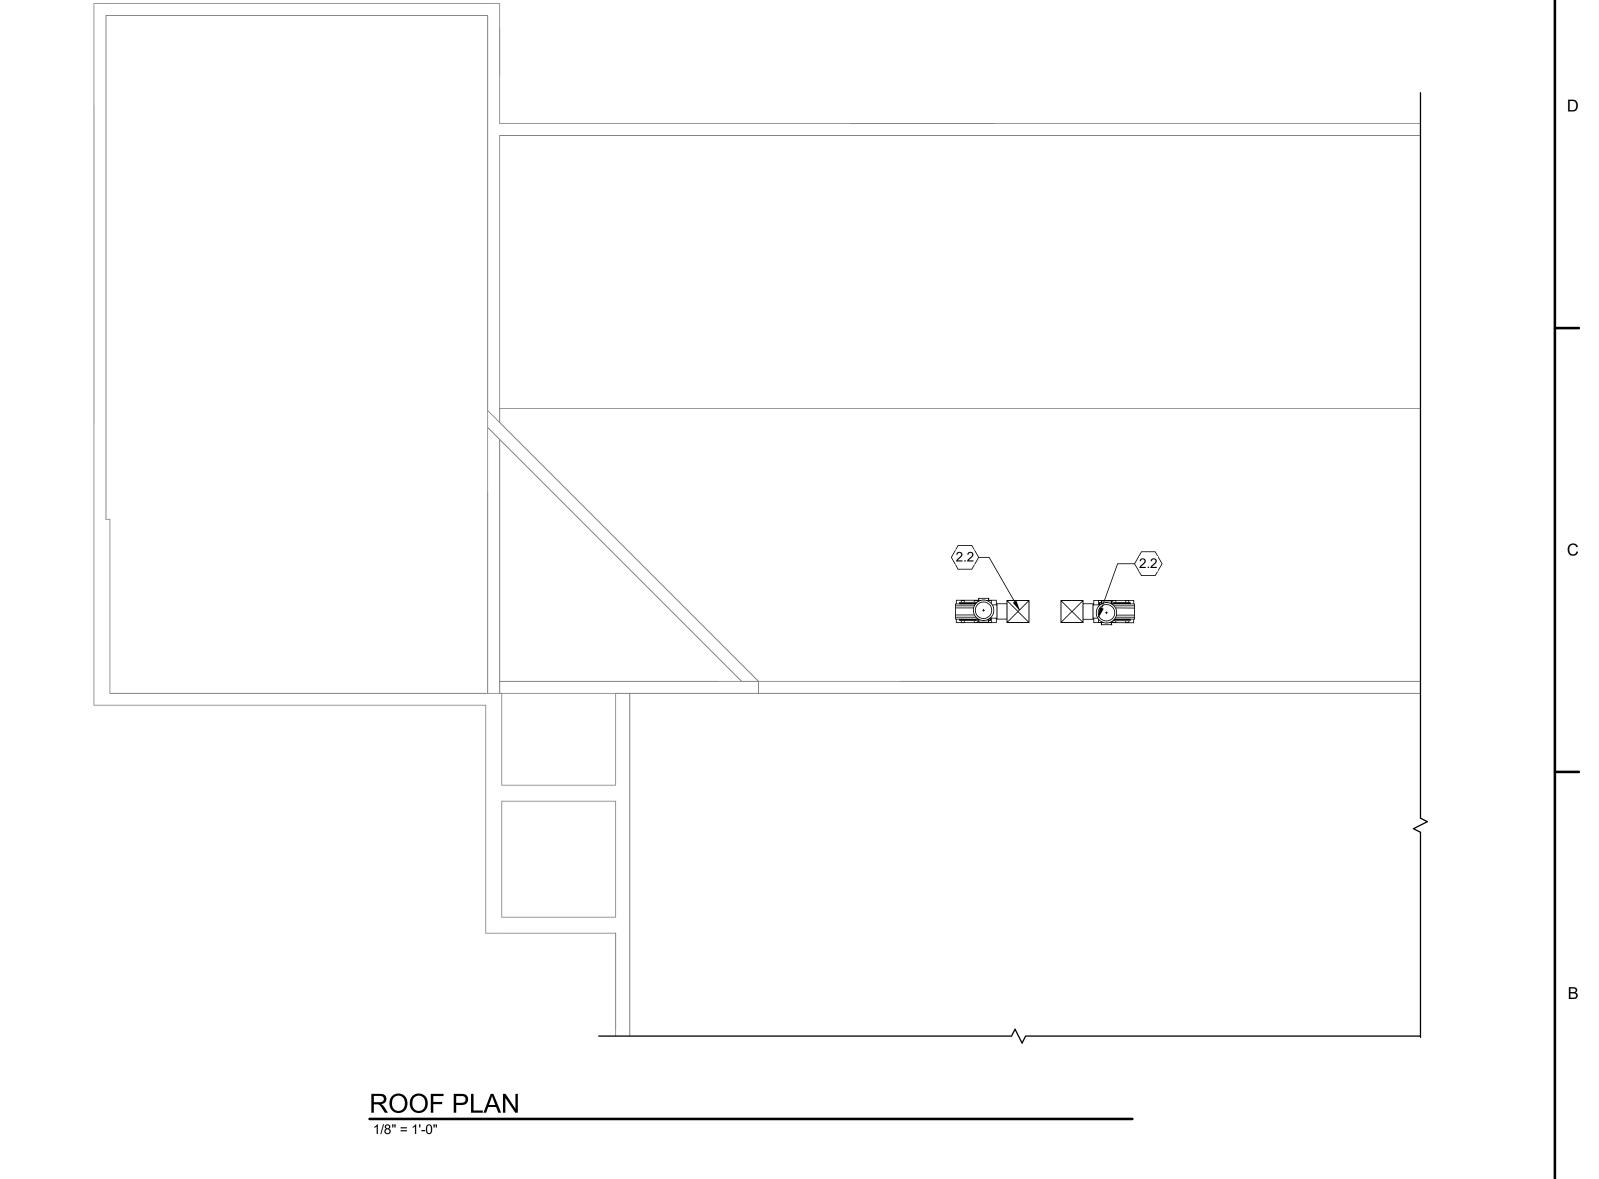

PROJECT MANAGER MICHAEL BUTTERFIELD ARCHITECTURAL JOHN S. RICKERT ELECTRICAL | KEVIN VANDER KOLK MECHANICAL JEFF LEWIS 04/26/2018 ISSUED FOR BID DATE DESCRIPTION PROJECT NUMBER | 10058757

CEDAR RAPIDS KJELDAHL HOOD **PROCUREMENT** **KJELDAHL HOOD REPLACEMENT**

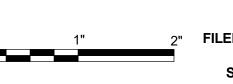

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02A101

SCALE NONE